


ELEVATIONS

SCALE: 1/8" = 1'-0"

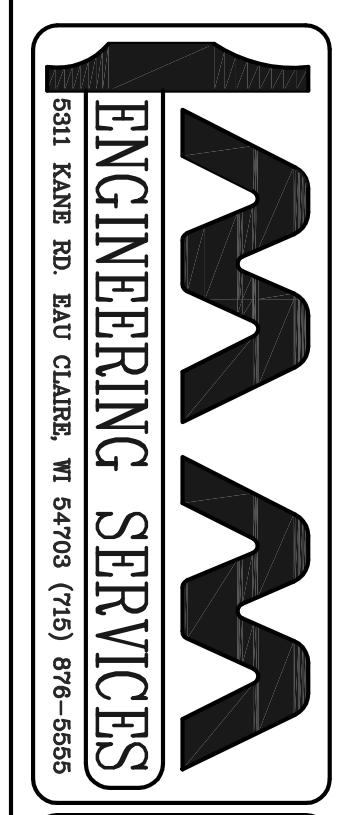

PROJECT TITLE:	JOB NAME	
	CITY, STATE	
SHEET TITLE:	ELEVATIONS	



REVISIONS	PROFESSIONAL ENGINEER: FILE NAME: XXXXXXXXXXXXXX	SHEET NO.
NO. DATE	DESCRIPTION BY PLAN DESIGNER:	
1		
2		
3		
4		

DRAWN BY: **XXXXXX** SCALE: **AS NOTED**


S2






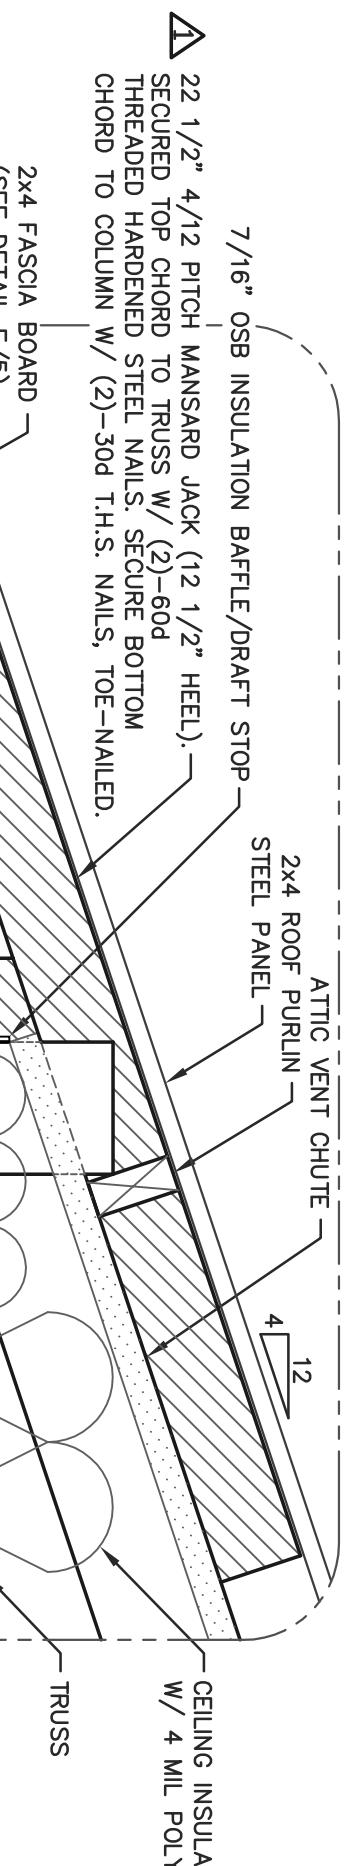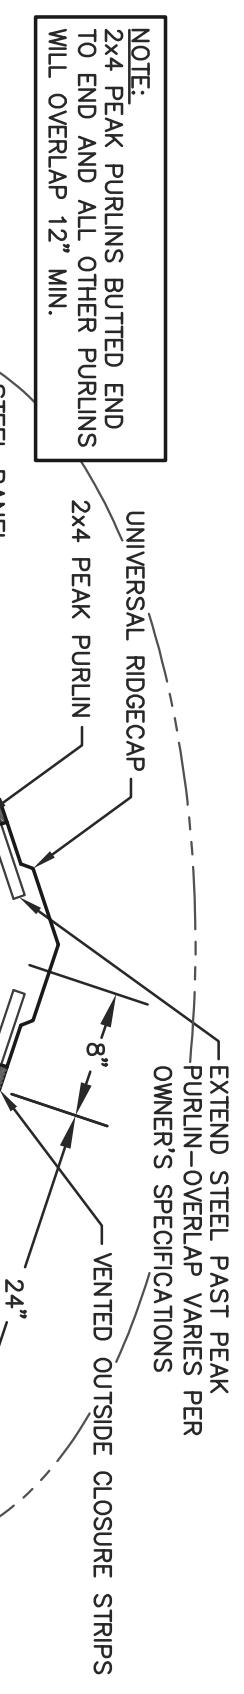



(D) 24" BOXED MANSARD EAVE DETAIL  
(5) SCALE: 1 1/2"=1'-0"

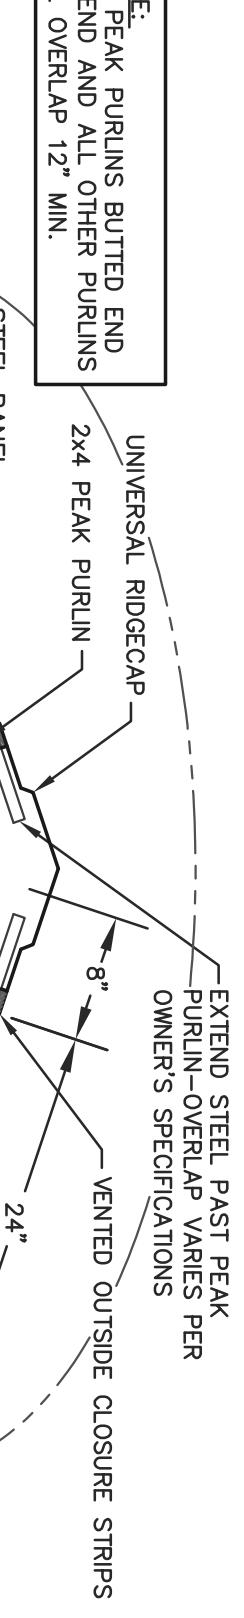


(E) PEAK PURLIN DETAIL  
(5) SCALE: 1 1/2"=1'-0"

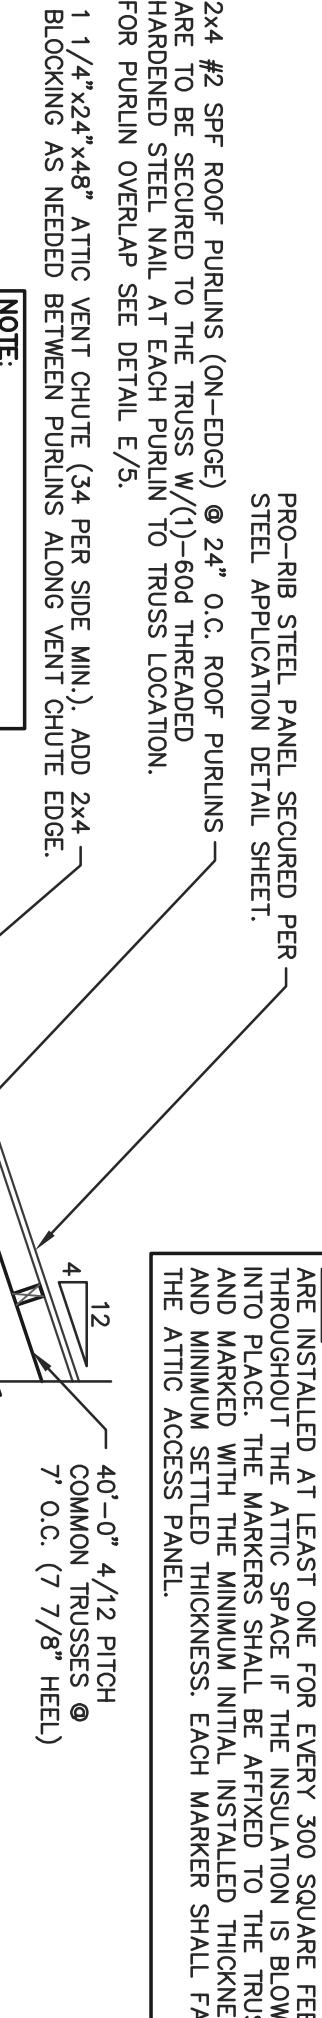


(F) PURLIN OVERLAP DETAIL  
(5) SCALE: 1 1/2"=1'-0"

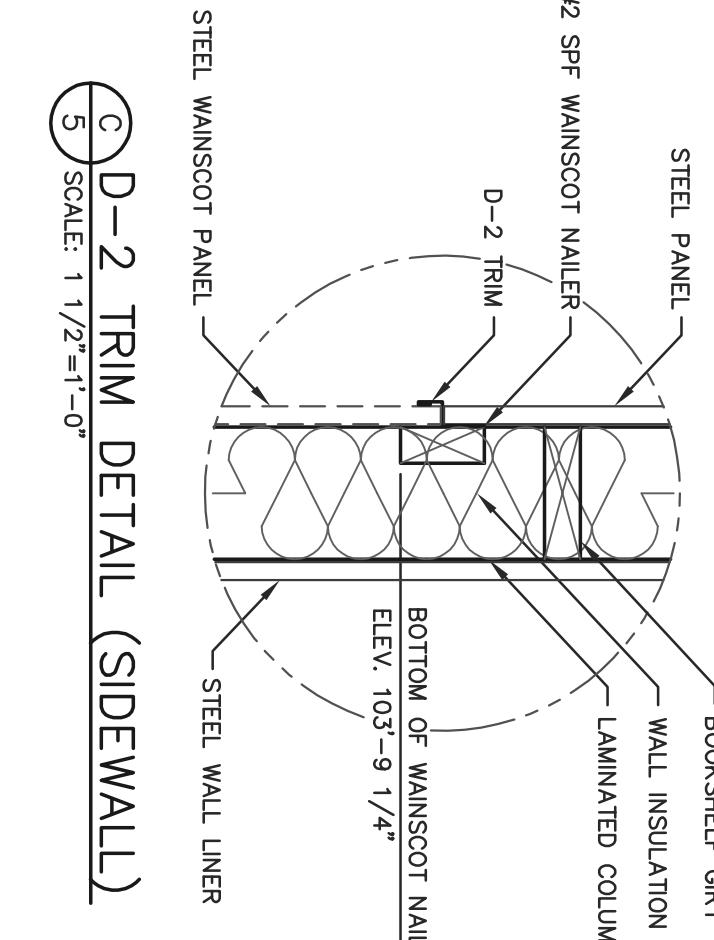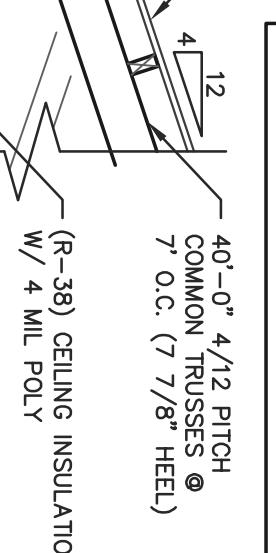


(C) D-2 TRIM DETAIL (SIDEWALL)  
(5) SCALE: 1 1/2"=1'-0"

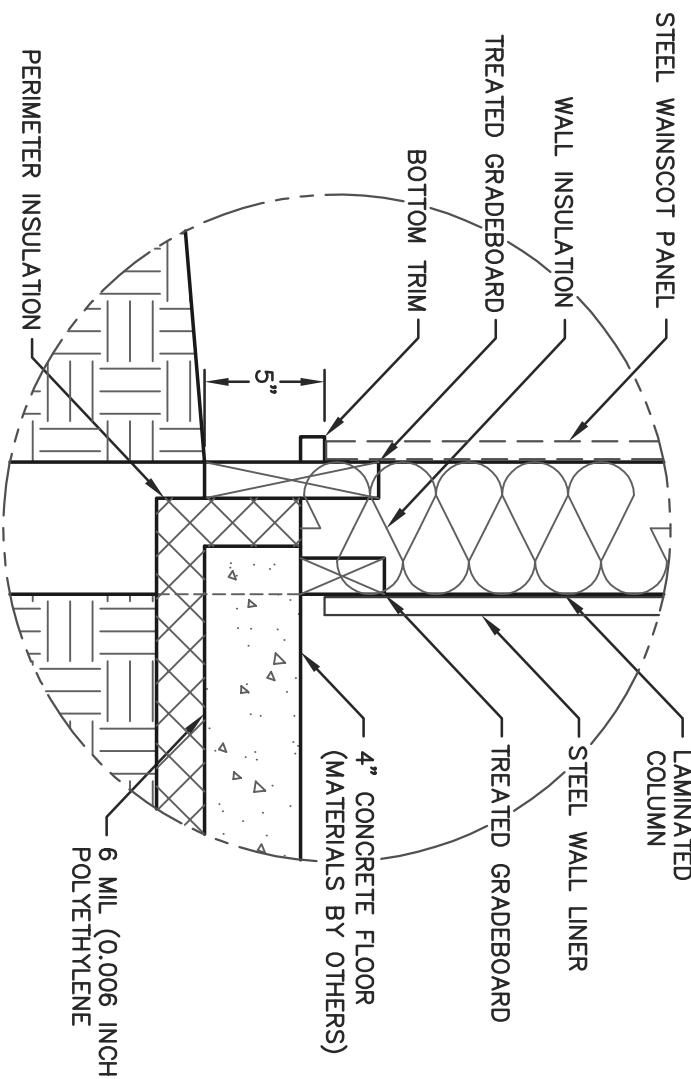


(B) GRADE DETAIL (SIDEWALL)  
(5) SCALE: 1 1/2"=1'-0"

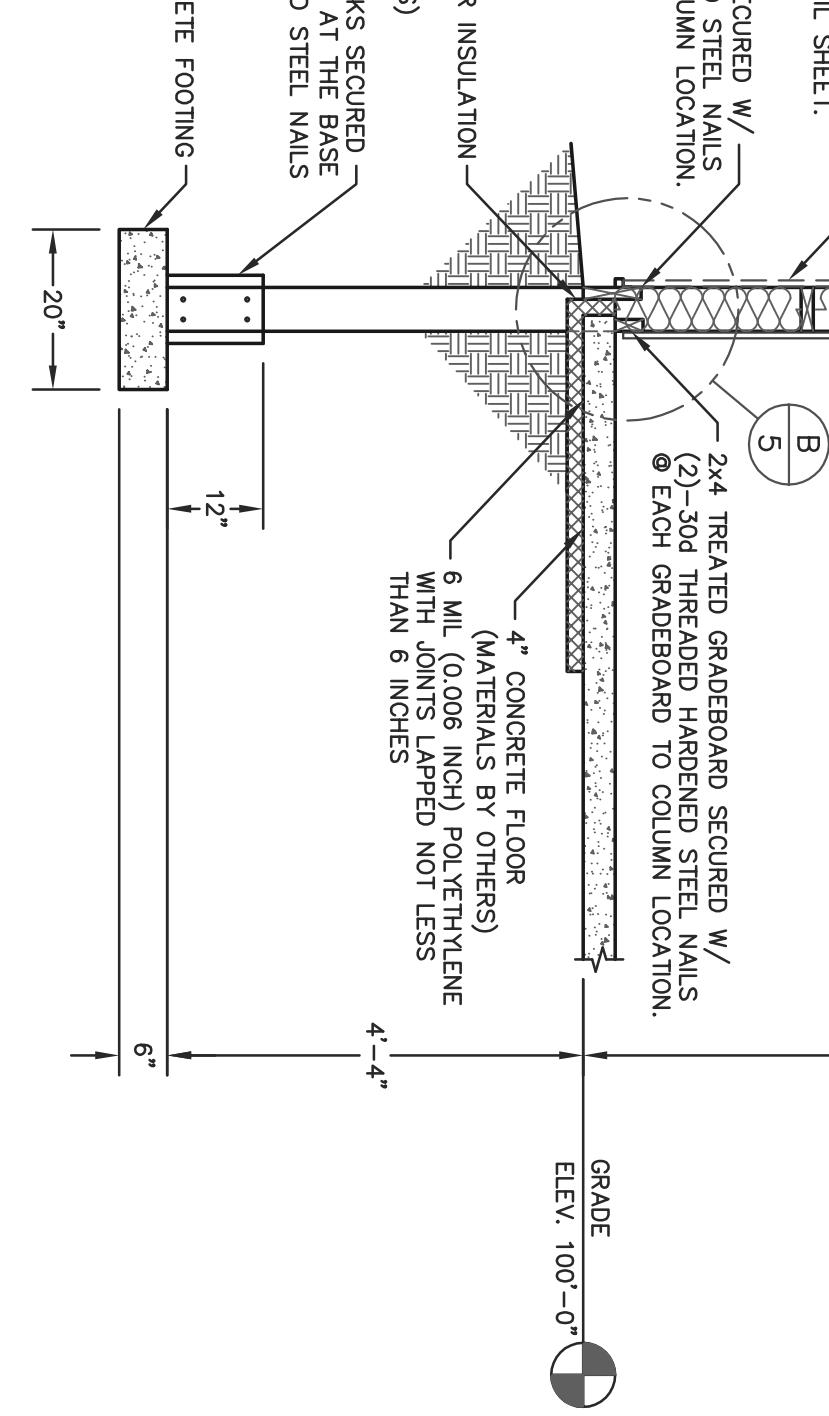

(A) SIDEWALL SECTION @ S1 COLUMNS  
(5) SCALE: 1/2"=1'-0"


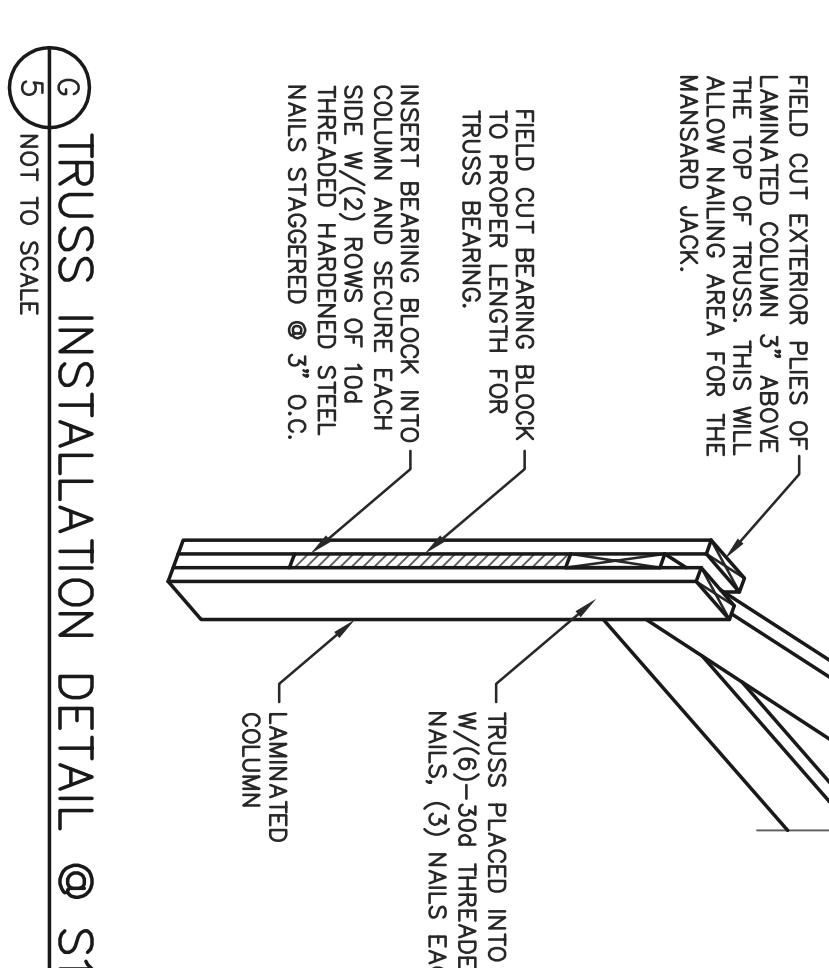


(G) TRUSS INSTALLATION DETAIL @ S1 COLUMNS  
(5) NOT TO SCALE


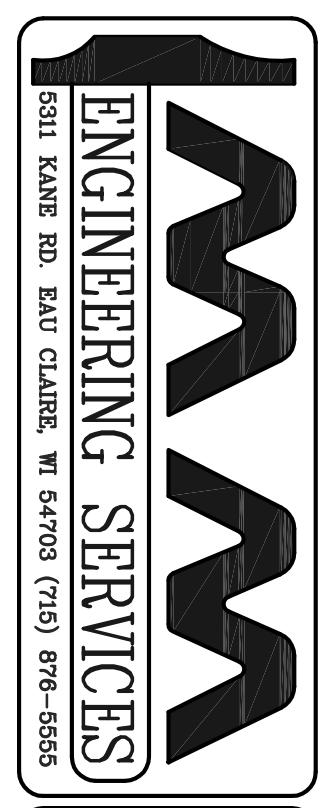


PROJECT TITLE:	JOB NAME
CITY, STATE	

REVISIONS	PROFESSIONAL ENGINEER: FILE NAME: XXXXXXXXXXXXXX	SHEET NO.
NO. DATE	DESCRIPTION BY XXXXXX-XXXXXX	
1	PLAN DESIGNER: XXXXXX-XXXXXX	
2	DATE: XXXXXXXXXXXX	
3	DRAWN BY: XXXXXX-XXXXXX	
4	SCALE: AS NOTED	

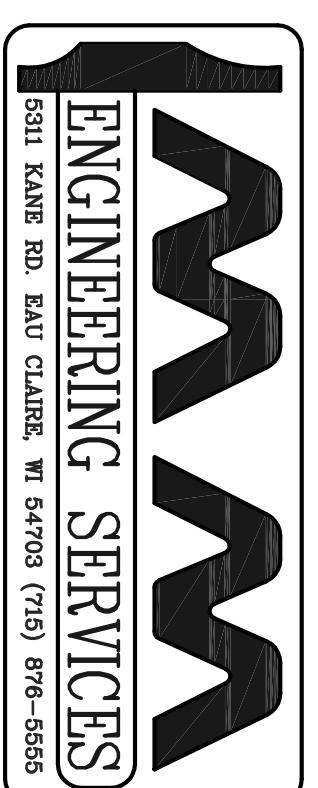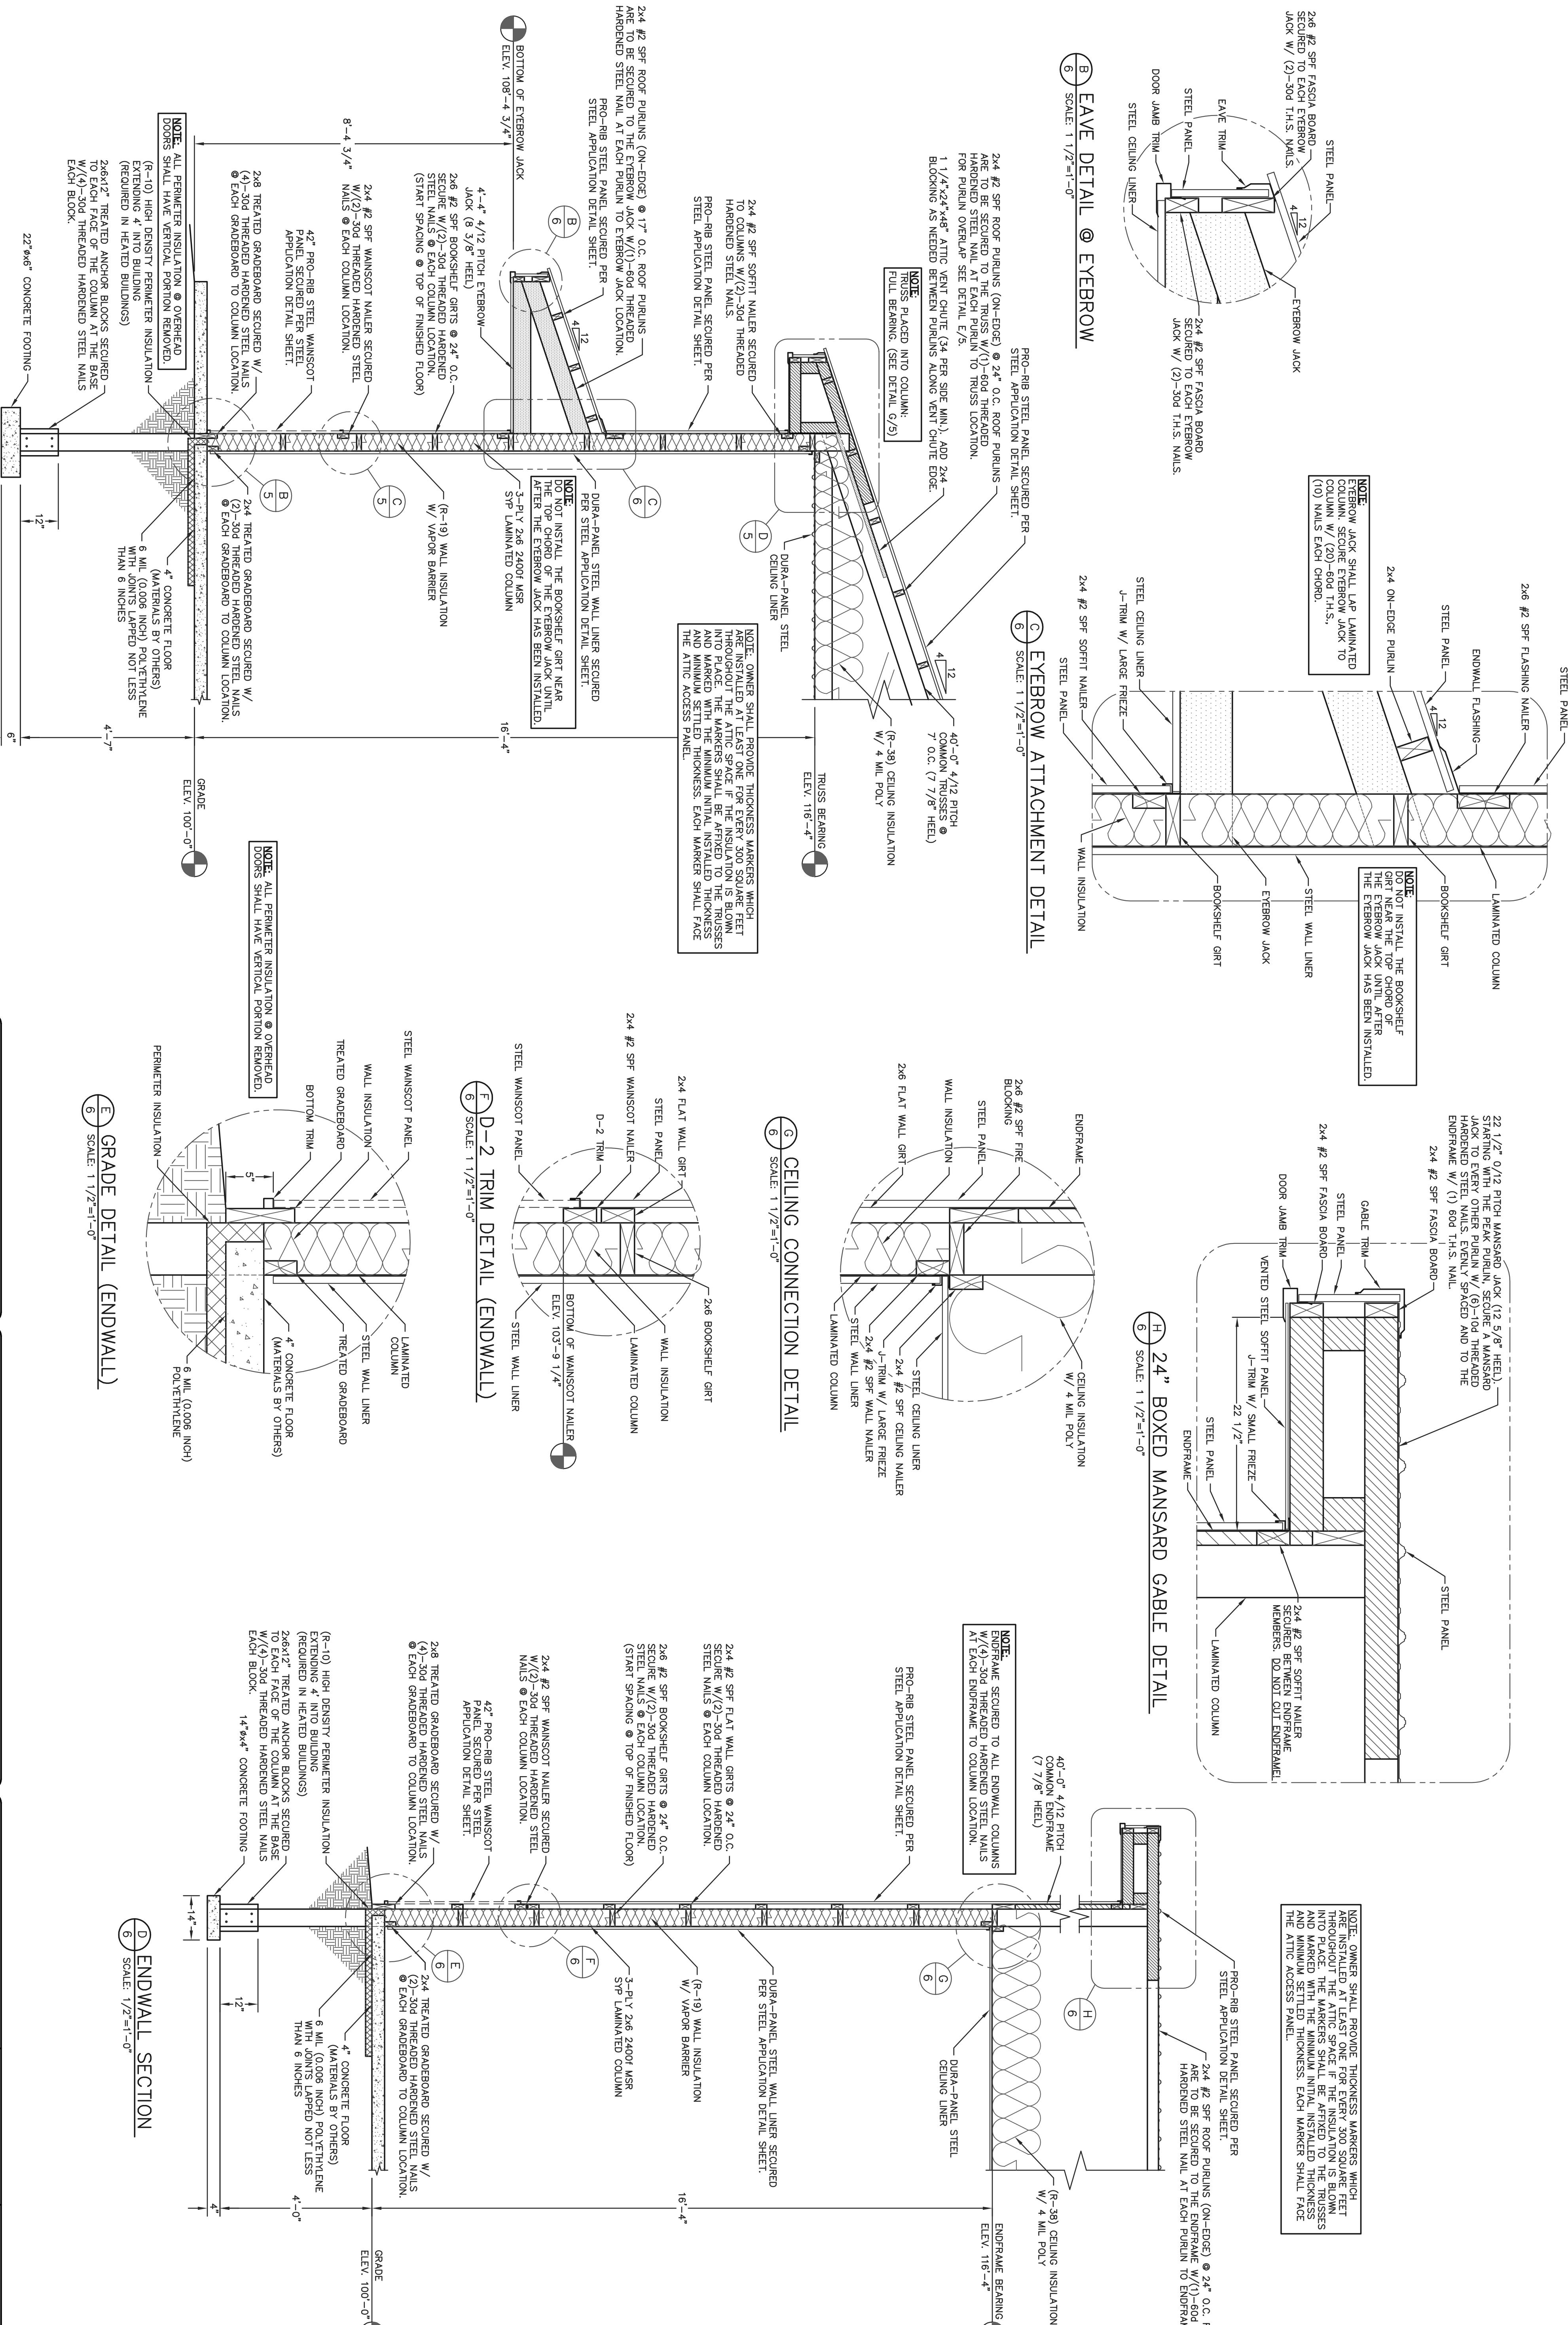

PROJECT TITLE:		REVISIONS		PROFESSIONAL ENGINEER:	FILE NAME:	SHEET NO.
		NO.	DATE	DESCRIPTION	BY	XXXXXX
		1			PLAN DESIGNER:	DATE:
		2			XXXXXX	XXXXXX
SHEET TITLE:		3		DRAWN BY:	SCALE:	S 6
SIDEWALL SECTION, ENDWALL SECTION & SECTION DETAILS		4		XXXXXX	AS NOTED	

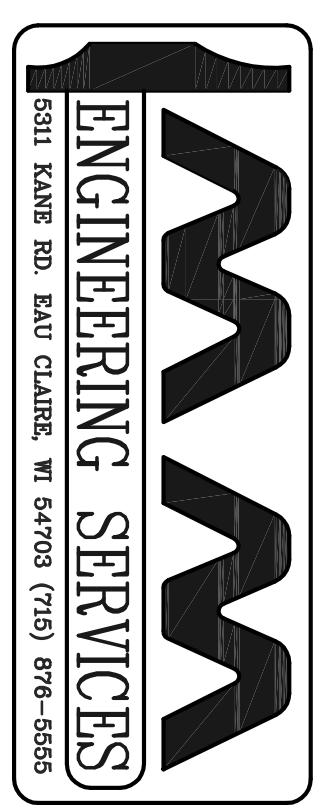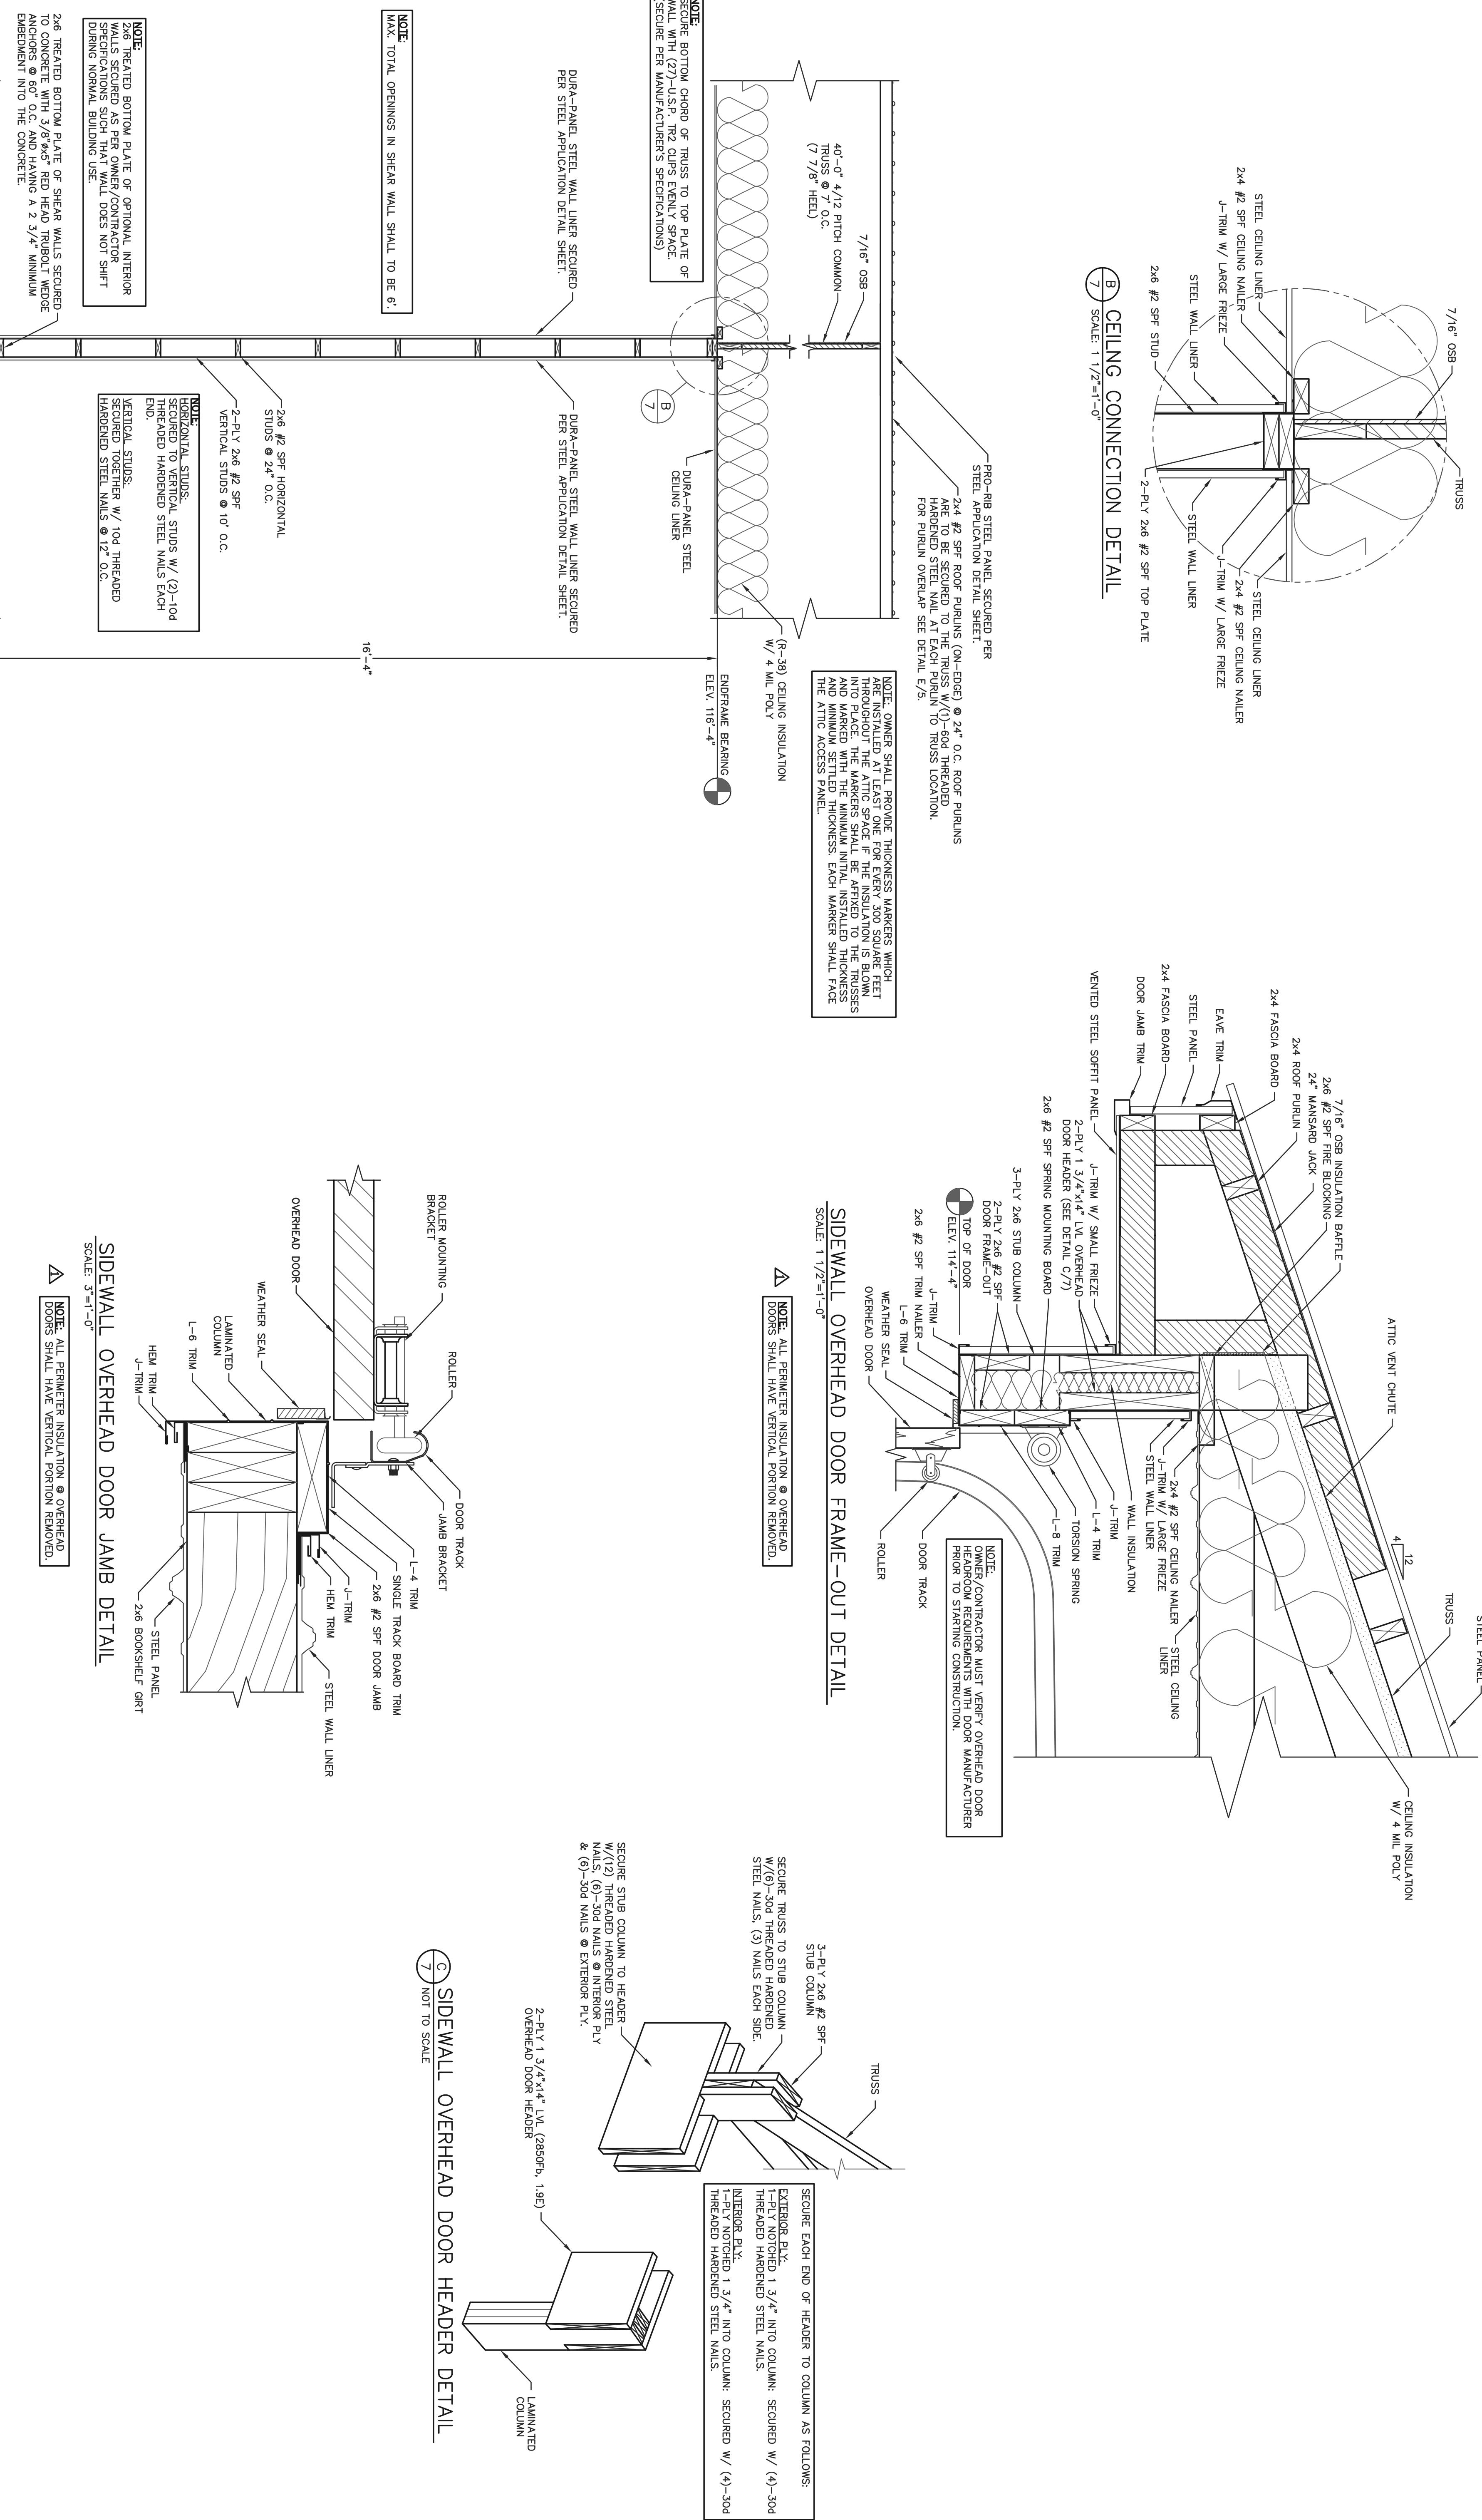

PROJECT TITLE:	JOB NAME
CITY, STATE	
SHEET TITLE: SHEAR WALL SECTION & OVERHEAD DOOR DETAILS	

REVISIONS: \_\_\_\_\_

PROFESSIONAL ENGINEER: FILE NAME: \_\_\_\_\_

SHEET NO. \_\_\_\_\_


NO. DATE: \_\_\_\_\_

BY: \_\_\_\_\_


REVISIONS: \_\_\_\_\_

NO. DATE: \_\_\_\_\_




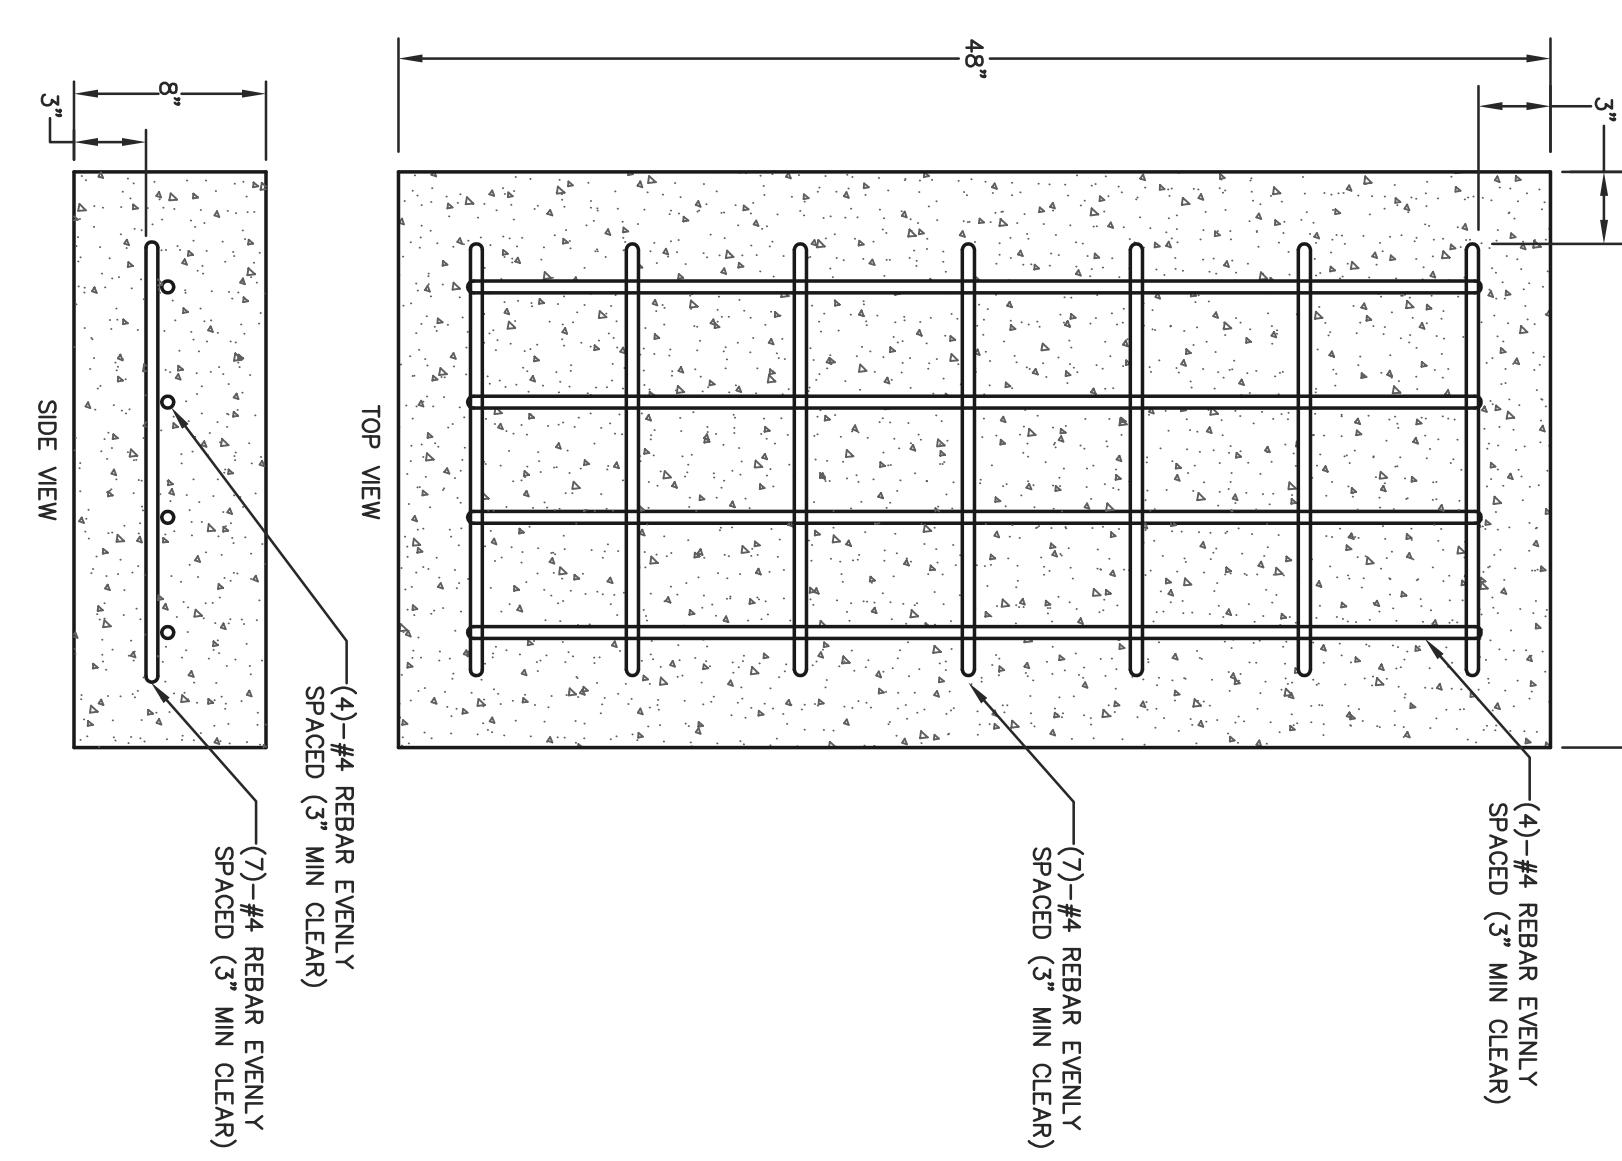


RESIRUUM FLUOR PLAN (TYPICAL)  
SCALE: 1/2"=1'-0"

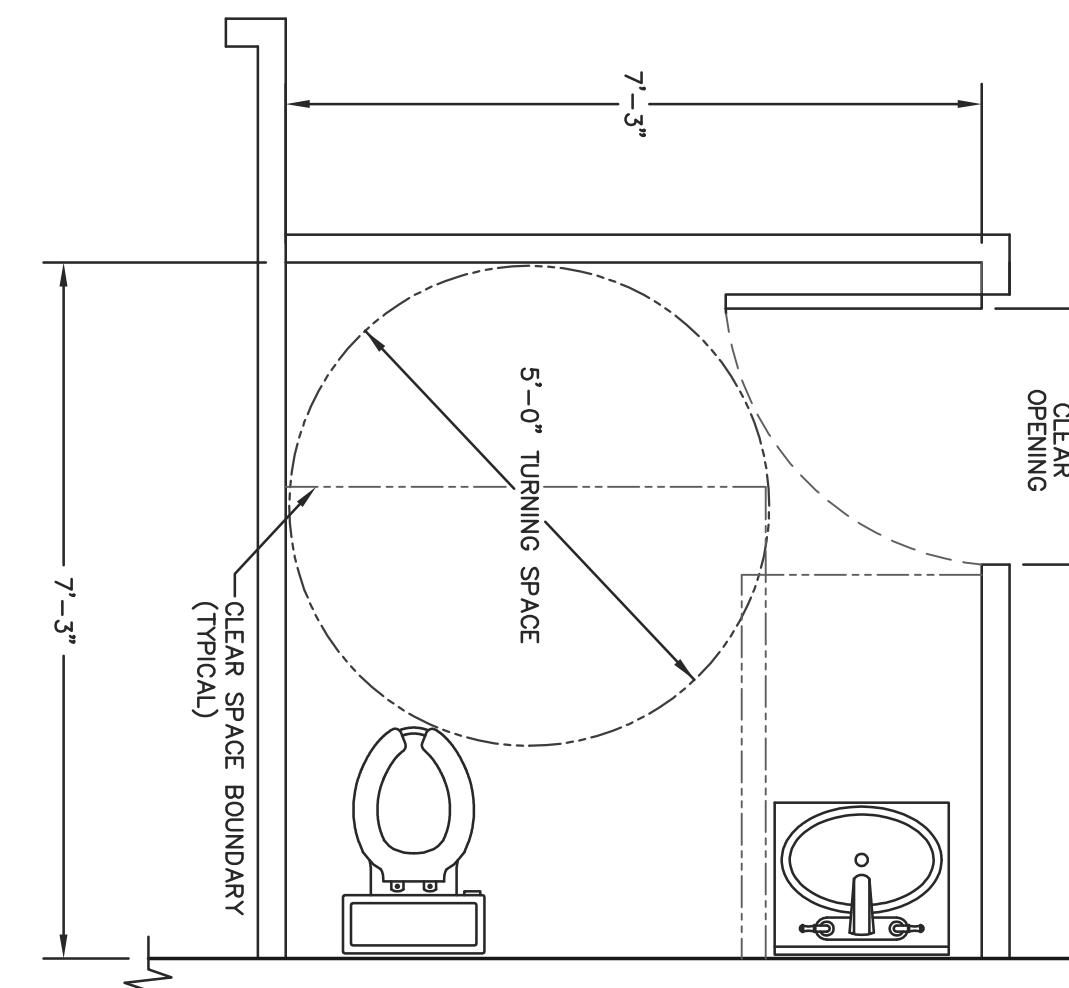


FRONT TOILET ELEVATION  
SCALE:  $3/8"=1'-0"$

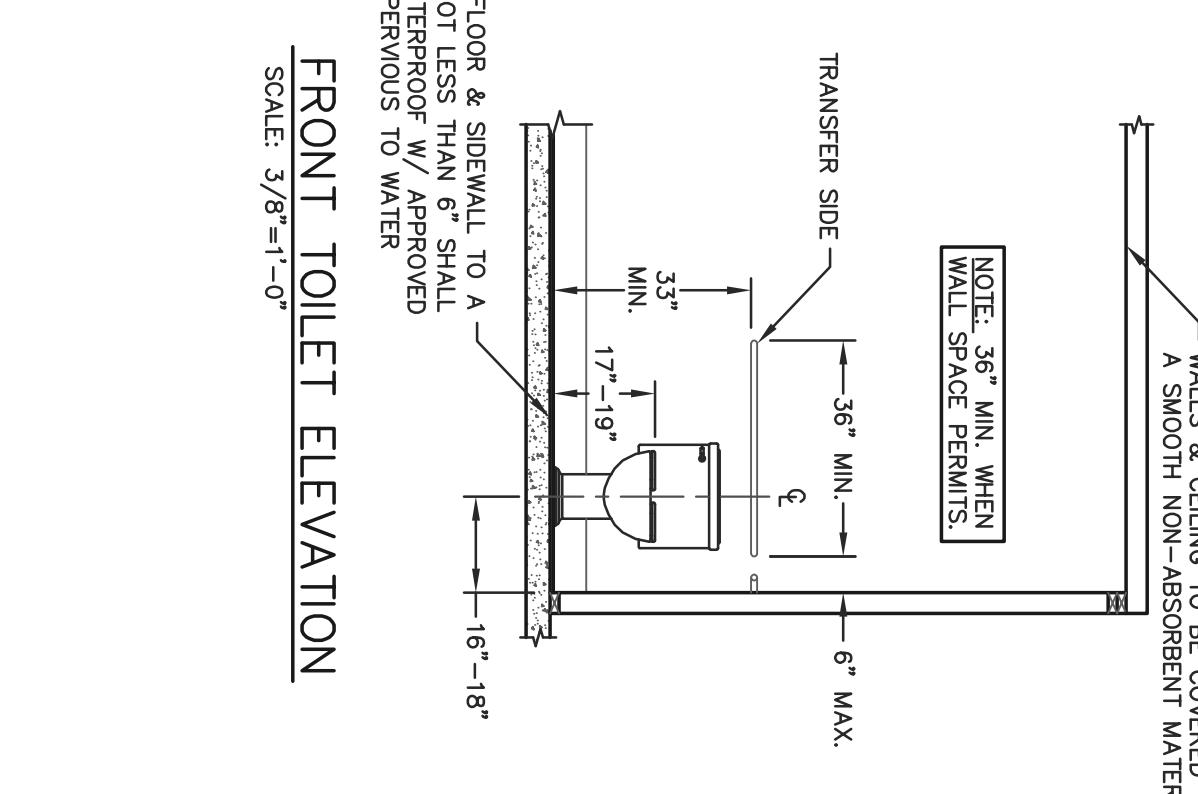


CLARK SI AUL REQUIREMENTS  
SCALE: 3/8"=1'-0"

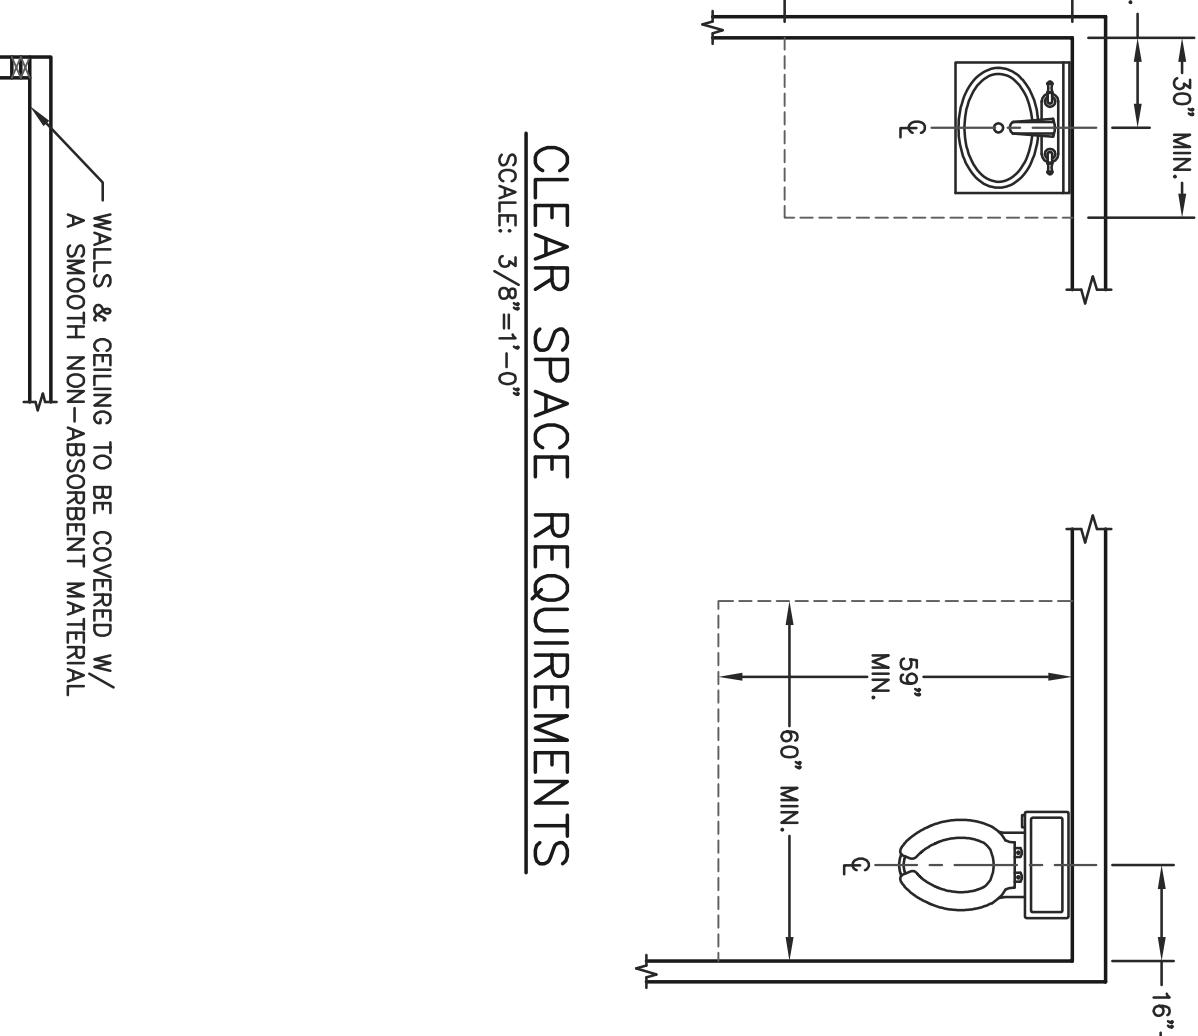


FRONT SINK ELEVATION  
SCALE:  $3/8" = 1' - 0"$

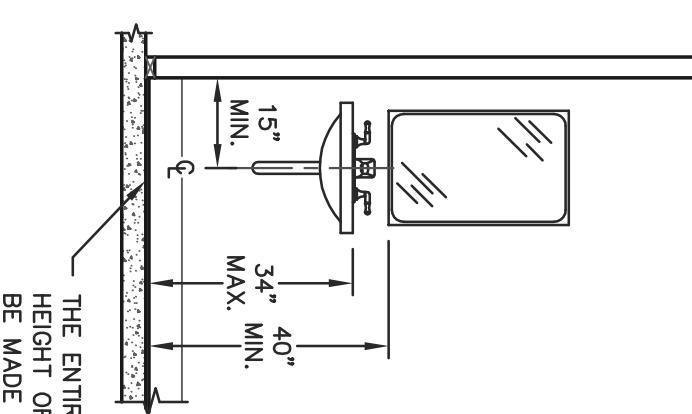

N - ABSORBENT MATERIAL

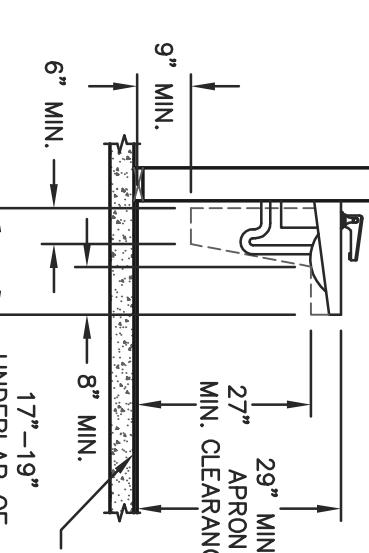


SIDE SINK ELEVATION  
SCALE:  $3/8'' = 1'-0''$

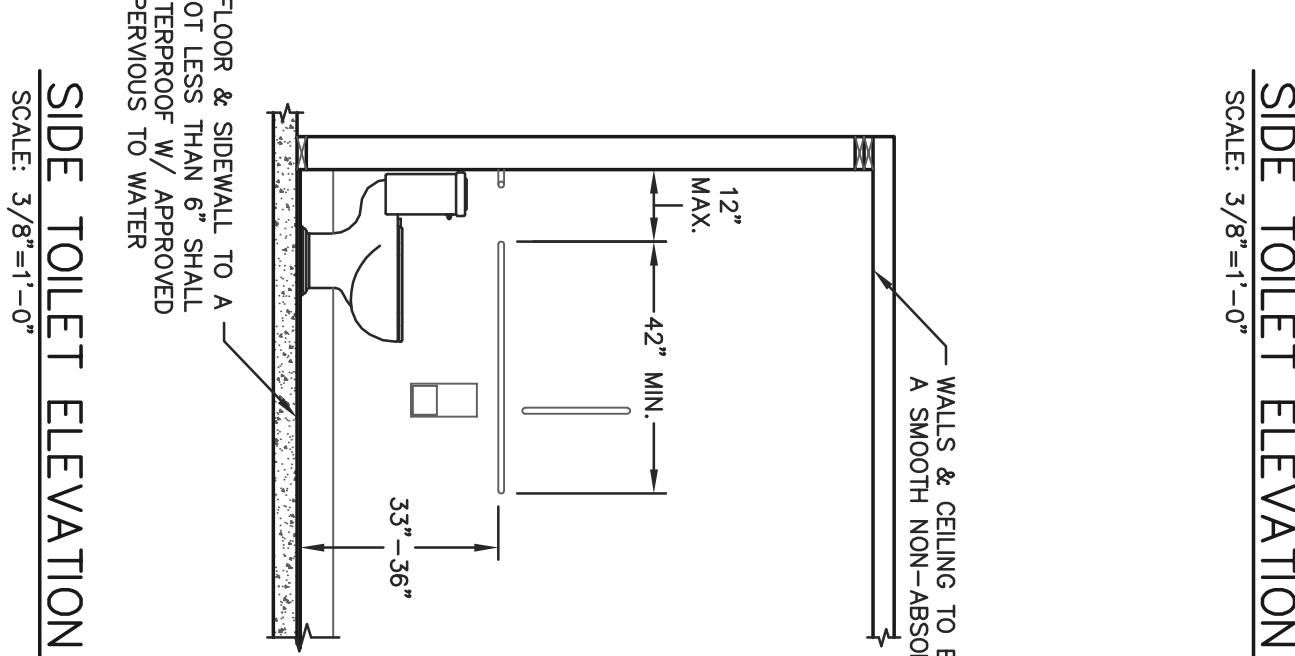

SIDE TOILET ELEVATION  
SCALE: 3/8"=1'-0"

GRAB BAR LOCATIONS

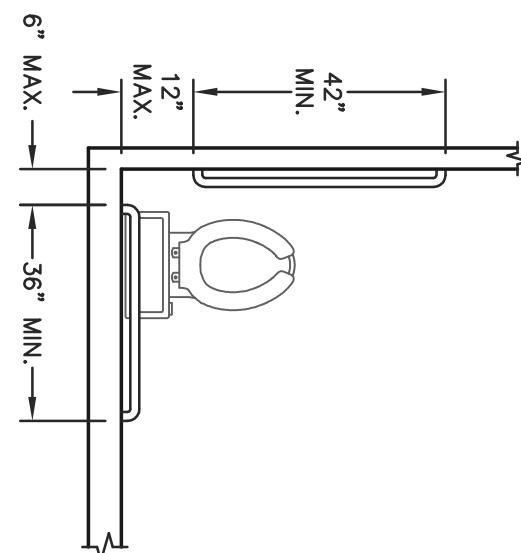

IN EACH BATHROOM OR TOILET ROOM, URINALS SHALL NOT BE SUBSTITUTED FOR MORE THAN 67% OF THE REQUIRED WATER CLOSETS IN ASSEMBLY AND EDUCATIONAL OCCUPANCIES. URINALS SHALL NOT BE SUBSTITUTED FOR MORE THAN 50% OF THE REQUIRED WATER CLOSETS IN ALL OTHER OCCUPANCIES.  
(PER IPC 419.2)

		PROJECT TITLE:	
		JOB NAME	
		CITY, STATE	
SHEET TITLE:		ACCESSION NUMBER	
5311 KANE RD. EAU CLAIRE, WI 54703 (715) 876-5555		100-00000000	
REVISIONS		PROFESSIONAL ENGINEER:	
NO.	DATE	DESCRIPTION	BY
1			XXXXXX XXXX
2			XXXXXX XXXX
3			XXXXXX XXXX
4			XXXXXX XXXX
DRAWN BY:		FILE NAME:	
S		XXXXXX XXXX	
SCALE:		SHEET NO.	
AS NOTED		10	